



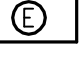
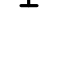
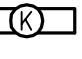



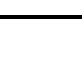
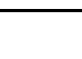







GENERAL LIGHTING INSTALLATION NOTES:	
L1.	REFER TO ELECTRICAL SPECIFICATIONS FOR FLUORESCENT LAMP COLOR AND BALLAST TYPE.
L2.	REFER TO LIGHTING FIXTURE DETAILS DRAWING 1-E4 FOR VISUAL REPRESENTATION OF FIXTURES.
L3.	CONTRACTOR SHALL COORDINATE LIGHTING FIXTURE TYPE (GRID OR FLANGE) WITH ACTUAL CEILING TYPE PRIOR TO ORDERING FIXTURES. CONTACT ENGINEER IF QUESTIONS SHOULD ARISE CONCERNING CEILING TYPES.
L4.	CONTRACTOR SHALL VERIFY ALL BALLAST QUANTITIES WITH SWITCHING SHOWN ON PLANS PRIOR TO ORDERING FIXTURES. ADJUST BALLAST QUANTITIES AS REQUIRED TO MATCH SWITCHING.
L5.	VERIFY LIGHTING CIRCUIT VOLTAGE (277V-1Ø OR 120V-1Ø) PRIOR TO ORDERING LIGHTING FIXTURES OR STARTING ROUGH-IN OF BRANCH CIRCUITS. IMMEDIATELY CONTACT ENGINEER WITH ANY DISCREPANCIES. CONTRACTOR IS RESPONSIBLE FOR ORDERING THE PROPER VOLTAGE FOR LIGHTING FIXTURES, REGARDLESS OF VOLTAGE SHOWN ON LIGHTING FIXTURE SCHEDULE.
L6.	CONTRACTOR SHALL VERIFY ALL FIXTURES TO BE CONTROLLED BY DIMMER SWITCHES AS SHOWN ON PLANS PRIOR TO ORDERING FIXTURES. PROVIDE ARCHITECTURAL DIMMING BALLASTS (FLUORESCENT) OR DRIVER (LED) WITH DIMMING RANGE FROM AS SHOWN TABLE ABOVE, AND COMPATIBLE DIMMER CONTROLS WHERE DIMMING IS INDICATED ON PLANS.
L7.	PROVIDE 100 HOURS BURN-IN TIME AT FULL BRIGHTNESS FOR ALL LAMPS IN DIMMED FLUORESCENT LIGHTING FIXTURES.
L8.	PROVIDE DISCONNECTING MEANS FOR ALL FLUORESCENT FIXTURES THAT UTILIZE DOUBLE-ENDED LAMPS AND CONTAIN BALLAST(S) THAT CAN BE SERVICED IN PLACE. THE DISCONNECTING MEANS SHALL BE ACCESSIBLE AND SHALL SIMULTANEOUSLY BREAK ALL THE SUPPLY CONDUCTORS TO THE BALLAST (INCLUDING THE GROUNDED CONDUCTOR).
L9.	REFER TO ELECTRICAL SPECIFICATIONS FOR LED COLOR TEMPERATURE AND DRIVER TYPE.
L10.	LINEAR FLUORESCENT LAMPS SHALL HAVE A CRI OF 82 OR GREATER.
L11.	COMPACT FLUORESCENT LAMPS SHALL HAVE A CRI OF 80 OR GREATER.
L12.	SUBMIT LAMP AND BALLAST CUT SHEETS WITH SHOP DRAWINGS FOR REVIEW.
L13.	REFER TO LIGHTING FIXTURE DETAILS DRAWING FOR REPRESENTATION OF FIXTURE STYLE.
L14.	LED FIXTURES MAY HAVE A COLOR TEMPERATURE FROM 4000-4200.


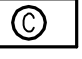
BALLAST/DRIVER ABBREVIATIONS	
LF BALLAST	LINEAR FLUORESCENT LAMP BALLAST
CF BALLAST	COMPACT FLUORESCENT LAMP BALLAST
LED DRIVER	LIGHT-EMITTING DIODE DRIVER WITH 100% DOWN TO 10% (OR LOWER) LOW-VOLTAGE DIMMING
DIMMING LF BALLAST	DIMMING LINEAR FLUORESCENT LAMP BALLAST 100% DOWN TO 5% (OR LOWER) OR AS NOTED.
DIMMING ADDRESS LF BALLAST	ADDRESSABLE DIMMING BALLAST 100% DOWN TO 5% (OR LOWER). MUST BE COMPATIBLE WITH OTHER ADVANCE LIGHTING CONTROLS - SEE ELECTRICAL LEGEND FOR ADDITIONAL WORK REQUIREMENTS.
DIMMING CF BALLAST	DIMMING COMPACT FLUORESCENT LAMP BALLAST
DIMMING LED DRIVER	DIMMING LIGHT-EMITTING DIODE DRIVER WITH 100% DOWN TO 1% DIMMING
120-277V	MULTI-VOLTAGE BALLAST DETECTS INCOMING VOLTAGE AND ADAPTS AUTOMATICALLY

LIGHTING FIXTURE SCHEDULE											
TYPE	DESCRIPTION	LOCATION	MOUNTING	LAMP INFORMATION				BALLAST/DRIVER INFORMATION			MANUFACTURER/NOTES
				QUANTITY	WATTS	TYPE	COLOR TEMP.	QUANTITY	TYPE	VOLTAGE	
	LED LIGHTING FIXTURE, 2' x 2' x 3-1/4"H, DUAL LUMINOUS PANEL OPTICAL SYSTEM WITH UNLIT CENTER, HIGH OPTICAL GRADE ACRYLIC LENS, PLANAR LIGHT GUIDE TECHNOLOGY UTILIZING EDGE-LIT PANELS, EXTRUDED ALUMINUM FRAME, L85 RATING OF AT LEAST 60,000 HOURS, MINIMUM 3400 LUMENS, 96 LUMENS PER WATT EFFICACY, HIGH REFLECTANCE BAKED MATTE WHITE ENAMEL FINISH, FUSING.	CORRIDOR/OFFICE	LAY-IN GRID	1	25.5W	LED	4100°K	1	0-10V DIMMING DRIVER	120-277V	-
	LED LIGHTING FIXTURE, 2' x 4' x 3-1/2" MAX HEIGHT RECESSED TROFFER, ACRYLIC K-19 LENS (.156" THICKNESS), FLAT WHITE STEEL DOOR FRAME, DIE FORMED STEEL RIGID HOUSING, 4800 MINIMUM DELIVERED LUMENS, MINIMUM OF 99 LUMEN PER WATT EFFICACY, AUXILIARY FIXTURE END SUSPENSION POINTS, FUSING, PAINT AFTER FABRICATION.	VARIOUS	LAY-IN GRID	1	50W MAX SYSTEM INPUT	LED	4100°K	1	LED DRIVER	120-277V	-
	LED LIGHTING FIXTURE, 2' x 4' x 3-1/4"H, DUAL LUMINOUS PANEL OPTICAL SYSTEM WITH UNLIT CENTER, HIGH OPTICAL GRADE ACRYLIC LENS, PLANAR LIGHT GUIDE TECHNOLOGY UTILIZING EDGE-LIT PANELS, EXTRUDED ALUMINUM FRAME, L85 RATING OF AT LEAST 60,000 HOURS, MINIMUM 3400 LUMENS, 96 LUMENS PER WATT EFFICACY, HIGH REFLECTANCE BAKED MATTE WHITE ENAMEL FINISH, FUSING.	VARIOUS	LAY-IN GRID	1	54W	LED	4100°K	1	0-10V DIMMING DRIVER	120-277V	-
	LED LIGHTING FIXTURE - 6" DIA. X 7" MAX HEIGHT RECESSED DOWNLIGHT, 1500 MINIMUM LUMENS, ALZAK SEMI-SPECULAR CLEAR REFLECTOR AND WHITE POLYMER TRIM, LED LIGHT BAR AND DRIVER ACCESSIBLE FROM BELOW THROUGH FIXTURE, CONVEX TRANSITIONAL LENS.	VARIOUS	LAY-IN GRID	1	23W MAX SYSTEM INPUT	LED	4100°K	1	LED DRIVER	277V	-
	LED LIGHTING FIXTURE, 2' x 4' x 3-1/2" MAX HEIGHT RECESSED TROFFER, ACRYLIC K-19 LENS (.156" THICKNESS), FLAT WHITE STEEL DOOR FRAME, DIE FORMED STEEL RIGID HOUSING, 6500 MINIMUM DELIVERED LUMENS, MINIMUM OF 96 LUMEN PER WATT EFFICACY, AUXILIARY FIXTURE END SUSPENSION POINTS, FUSING, PAINT AFTER FABRICATION.	HOT LAB	LAY-IN GRID	1	65W MAX SYSTEM INPUT	LED	4100°K	1	0-10V DIMMING DRIVER	120-277V	-
	LED LIGHTING FIXTURE - 23.5"Lx2-1/4"Hx3"D ARCHITECTURAL WALL MOUNTED VANITY WITH MATTE WHITE INNER DIFFUSER AND CLEAR ACRYLIC DIFFUSER, STEEL HOUSING W/ MATTE SILVER POWDER COAT FINISH, 2028 LUMEN OUTPUT.	BATHROOM	WALL MOUNT AT 8'-0" AFF	1	20W MAX SYSTEM INPUT	LED	4100K	1	LED	120-277V	-
	LED LIGHTING FIXTURE, 7" x 4' x 6" MAX HEIGHT VAPORLUME FIXTURE, 5680 MINIMUM LUMEN OUTPUT, WIDE DISTRIBUTION, FUSING, WHITE MOLDED FIBERGLASS REINFORCED POLYESTER BODY, HIGH IMPACT ACRYLIC MOLDED LENS, GASKET, LISTED FOR WET LOCATION, STAINLESS STEEL MOUNTING BRACKETS.	MECH/ELEC ROOMS	MOUNT ON UNISTRUT SUSPENDED FROM CEILING AT 8'-6" AFF TO BOTTOM OF FIXTURE	1	72W MAX SYSTEM INPUT	LED	4000°K	1	LF BALLAST	120-277V	-
	LED LIGHTING FIXTURE, 2' x 2' x 3-1/4"H, DUAL LUMINOUS PANEL OPTICAL SYSTEM WITH UNLIT CENTER, HIGH OPTICAL GRADE ACRYLIC LENS, PLANAR LIGHT GUIDE TECHNOLOGY UTILIZING EDGE-LIT PANELS, EXTRUDED ALUMINUM FRAME, L85 RATING OF AT LEAST 60,000 HOURS, MINIMUM 3400 LUMENS, 96 LUMENS PER WATT EFFICACY, HIGH REFLECTANCE BAKED MATTE WHITE ENAMEL FINISH, FUSING.	VARIOUS	LAY-IN GRID	1	35W	LED	4100°K	1	0-10V DIMMING DRIVER	120-277V	-
	LED LIGHTING FIXTURE - 2-0'Lx5-3-1/2"Hx7-1/2"D WALL MOUNTED LENSED STRIPLIGHT FIXTURE WITH CLEAR LENS, FUSING, PAINTED AFTER FABRICATION, MATTE WHITE ENAMEL FINISH, MINIMUM 65,000 HOUR L70, MINIMUM OF 2300 LUMEN OUTPUT, MINIMUM OF 98 LUMENS PER WATT EFFICACY.	STORAGE	WALL MOUNT ABOVE DOOR	1	17W	LED	4100K	1	LF BALLAST	120-277V	-
	LED LIGHTING FIXTURE - 6" DIA. X 7" MAX HEIGHT RECESSED DOWNLIGHT, 2000 MINIMUM LUMENS, SEMI-SPECULAR CLEAR REFLECTOR AND WHITE POLYMER TRIM, LED LIGHT BAR AND DRIVER ACCESSIBLE FROM BELOW THROUGH FIXTURE, WIDE-THOW CONVEX TRANSITIONAL LENS.	EXAM	LAY-IN GRID	1	32W MAX SYSTEM INPUT	LED	4100°K	1	DIMMING LED DRIVER	277V	-
	LED LIGHTING FIXTURE - 4" DIA. X 7" MAX HEIGHT RECESSED DOWNLIGHT, 1200 MINIMUM LUMENS, SEMI-SPECULAR CLEAR REFLECTOR AND WHITE POLYMER TRIM, LED LIGHT BAR AND DRIVER ACCESSIBLE FROM BELOW THROUGH FIXTURE, CONVEX TRANSITIONAL LENS.	VARIOUS	-	1	22W MAX SYSTEM INPUT	LED	4100°K	1	LED DRIVER	277V	-
	LED LIGHTING FIXTURE - 6"W X 5" MAX HEIGHT X 4'-0" LENGTH ON DRAWINGS, MATTE SATIN WHITE FINISH, FLUSH FROSTED LENS, L85 RATING AT 50,000 HOURS, MINIMUM OF 2400 DELIVERED LUMENS, COMPATIBLE WITH SPECIALTY GRID SYSTEM - COORDINATE WITH GC.	WAITING	SPECIALTY GRID SYSTEM	1	31W MAX SYSTEM INPUT	LED	4100°K	1	0-10V DIMMING DRIVER	277V	-
	LED LIGHTING FIXTURE - 7"W X 7.25"H X CUSTOM LENGTH ON DRAWINGS, 3.75" APERTURE PERIMETER WALL GRAZE LIGHTING FIXTURE, ADJUSTABLE 30 DEGREES TO GRAZE PEAK CANDELA DOWN WALL. MOUNT FIXTURE TO CEILING AND WALL. PROVIDE CONTINUOUS ROW LENGTH AS INDICATED ON DRAWINGS.	WAITING	DRYWALL CEILING AND WALL	1	7.6W/FT	LED	4100°K	1	LF BALLAST	277V	-
	FLUORESCENT LIGHTING FIXTURE - 7"W X 3"H X 92.5"L COVE LIGHTING FIXTURE, ADJUSTABLE ASYMMETRIC SPECULAR ALUMINUM REFLECTOR, LIGHTING FIXTURE MOUNTS IN PREFABRICATED EXTRUDED ALUMINUM COVE FRAME SYSTEM AND GYPSUM BOARD FASTENS DIRECTLY TO FRAME. GC SHALL INSTALL COVE FRAME SYSTEM FOR VERTICAL OR HORIZONTAL ILLUMINATION AS INDICATED ON ARCHITECTURAL SECTIONS. PROVIDE CONTINUOUS ROW LENGTH AS INDICATED ON DRAWINGS.	CORRIDOR	COVE	2	54	T5HO	4100°K	1	LF BALLAST	277V	-
	EXIT SIGN - LED TYPE, AC ONLY, SINGLE OR DOUBLE FACE, UNIVERSAL MOUNTING, DIE CAST ALUMINUM HOUSING WITH WHITE BODY, WHITE FACE AND RED STENCIL LETTERS. CONNECT TO EMERGENCY LIFE SAFETY CIRCUIT AHEAD OF LOCAL SWITCHING. UL 924 LISTED, UL DAMP LOCATION, UL LISTED FOR 2C.	VARIOUS		-	LESS THAN 2W	LED	-	-	-	120-277V	-
	EMERGENCY BATTERY LIGHTING UNIT - SEALED LEAD CALCIUM BATTERY, HIGH-IMPACT POLYCARBONATE HOUSING, SELF-DIAGNOSTIC CIRCUITRY, PUSHBUTTON TEST SWITCH/POWER INDICATOR LIGHT. CONNECT AHEAD OF LOCAL SWITCHING (UNSWITCHED "HOT" LIGHTING CIRCUIT). WALL MOUNT AT 90" ABOVE FINISHED FLOOR UNLESS OTHERWISE NOTED.	VARIOUS		2	12W	PAR26	-	-	-	120-277V	-
	L.E.D. WARNING LIGHT - 120/277V DUAL VOLTAGE INPUT, LED TYPE, AC ONLY, UNIVERSAL MOUNTING, SINGLE FACE, DIECAST ALUMINUM HOUSING WITH WHITE FINISH, RED STENCIL LETTERS ON WHITE FACE - "ROOM IN USE".	VARIOUS		1		LED				120-277V	


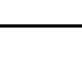
		CONSULTANTS:				ARCHITECT:		Drawing Title LIGHTING FIXTURE SCHEDULE		Project Title EXPAND AND RENOVATE NUCLEAR MEDICINE AND RADIOLOGY		Project Number 541-14-101		Office of Facilities Management 			
		 BARBER & HOFFMAN, INC. <i>Consulting Engineers</i>		 13212 Shaker Square Suite 204 Cleveland, Ohio 44120 P. 216.752.1800 F.216.752.3833		Approved: Project Director		Location VAMC - WADE PARK		Building Number 1		Drawing Number 1-E1.2					
Bid Issue Revisions:		01/17/14 Date						Date 1-17-2014		Checked MPL		Drawn TAG					

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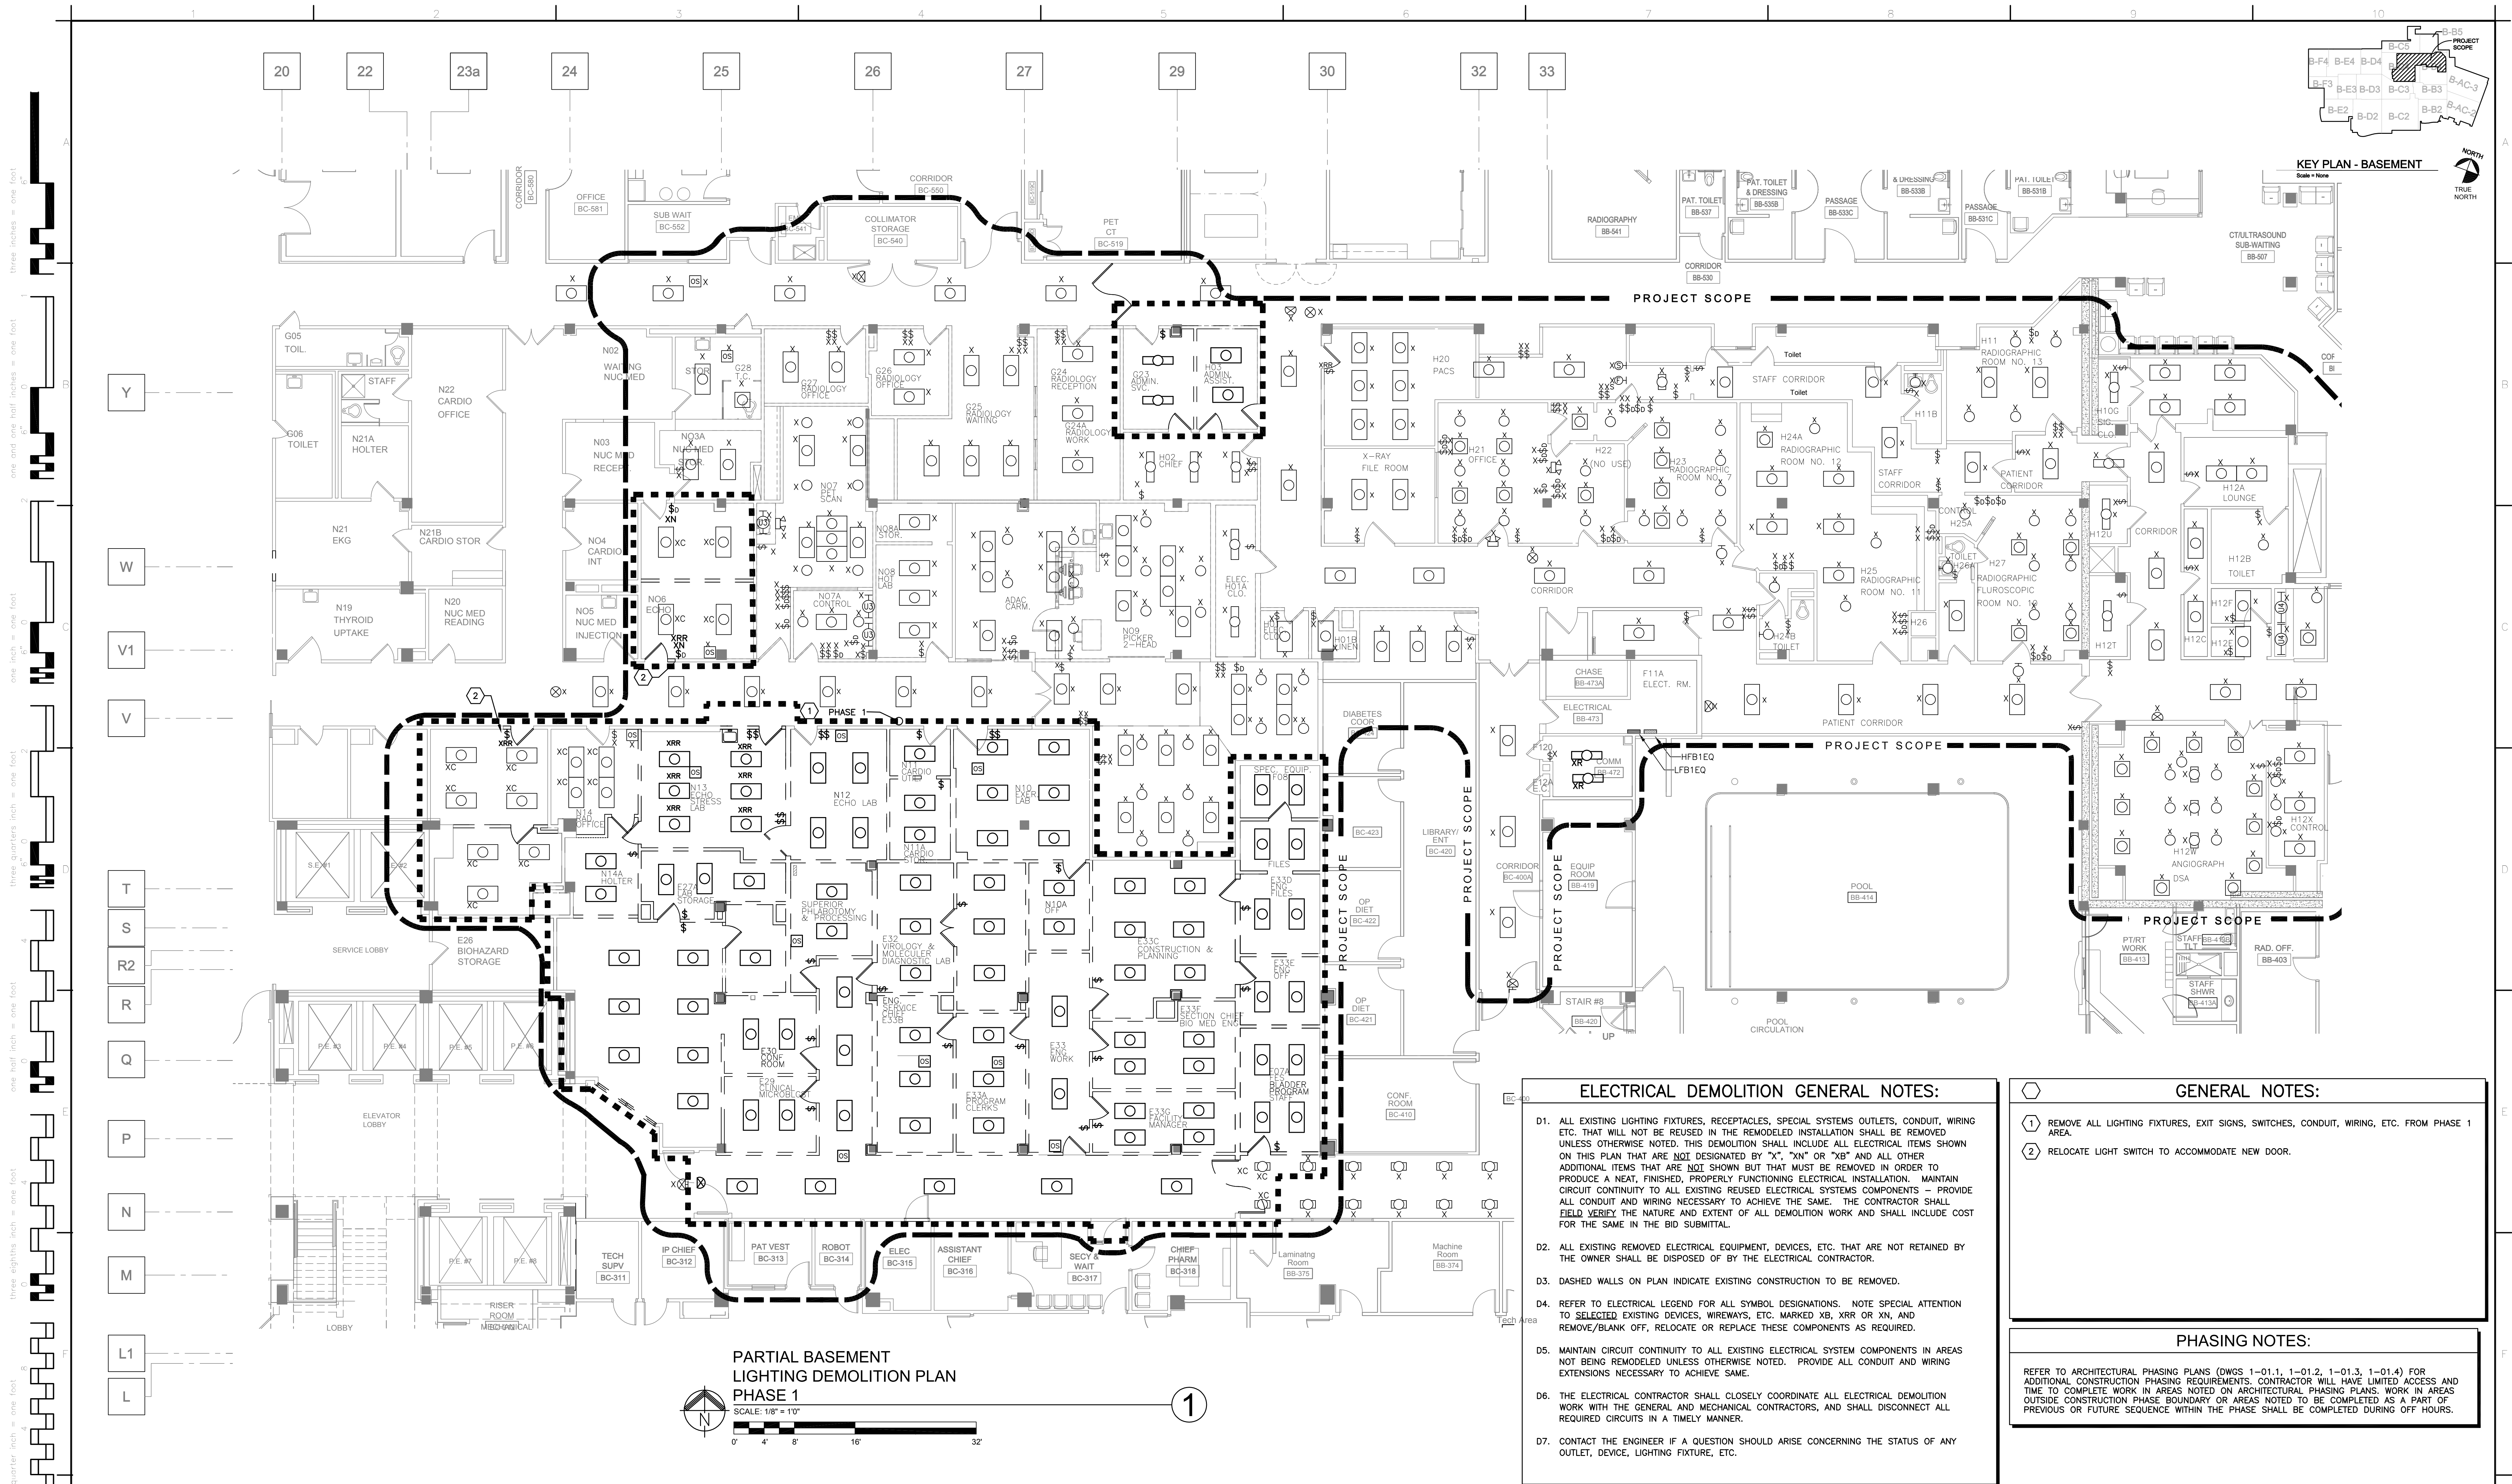
three inches = one foot
one and one half inches = one foot
one inch = one foot
three quarters inch = one foot
one half inch = one foot
three eighths inch = one foot
one quarter inch = one foot
one eighth inch = one foot

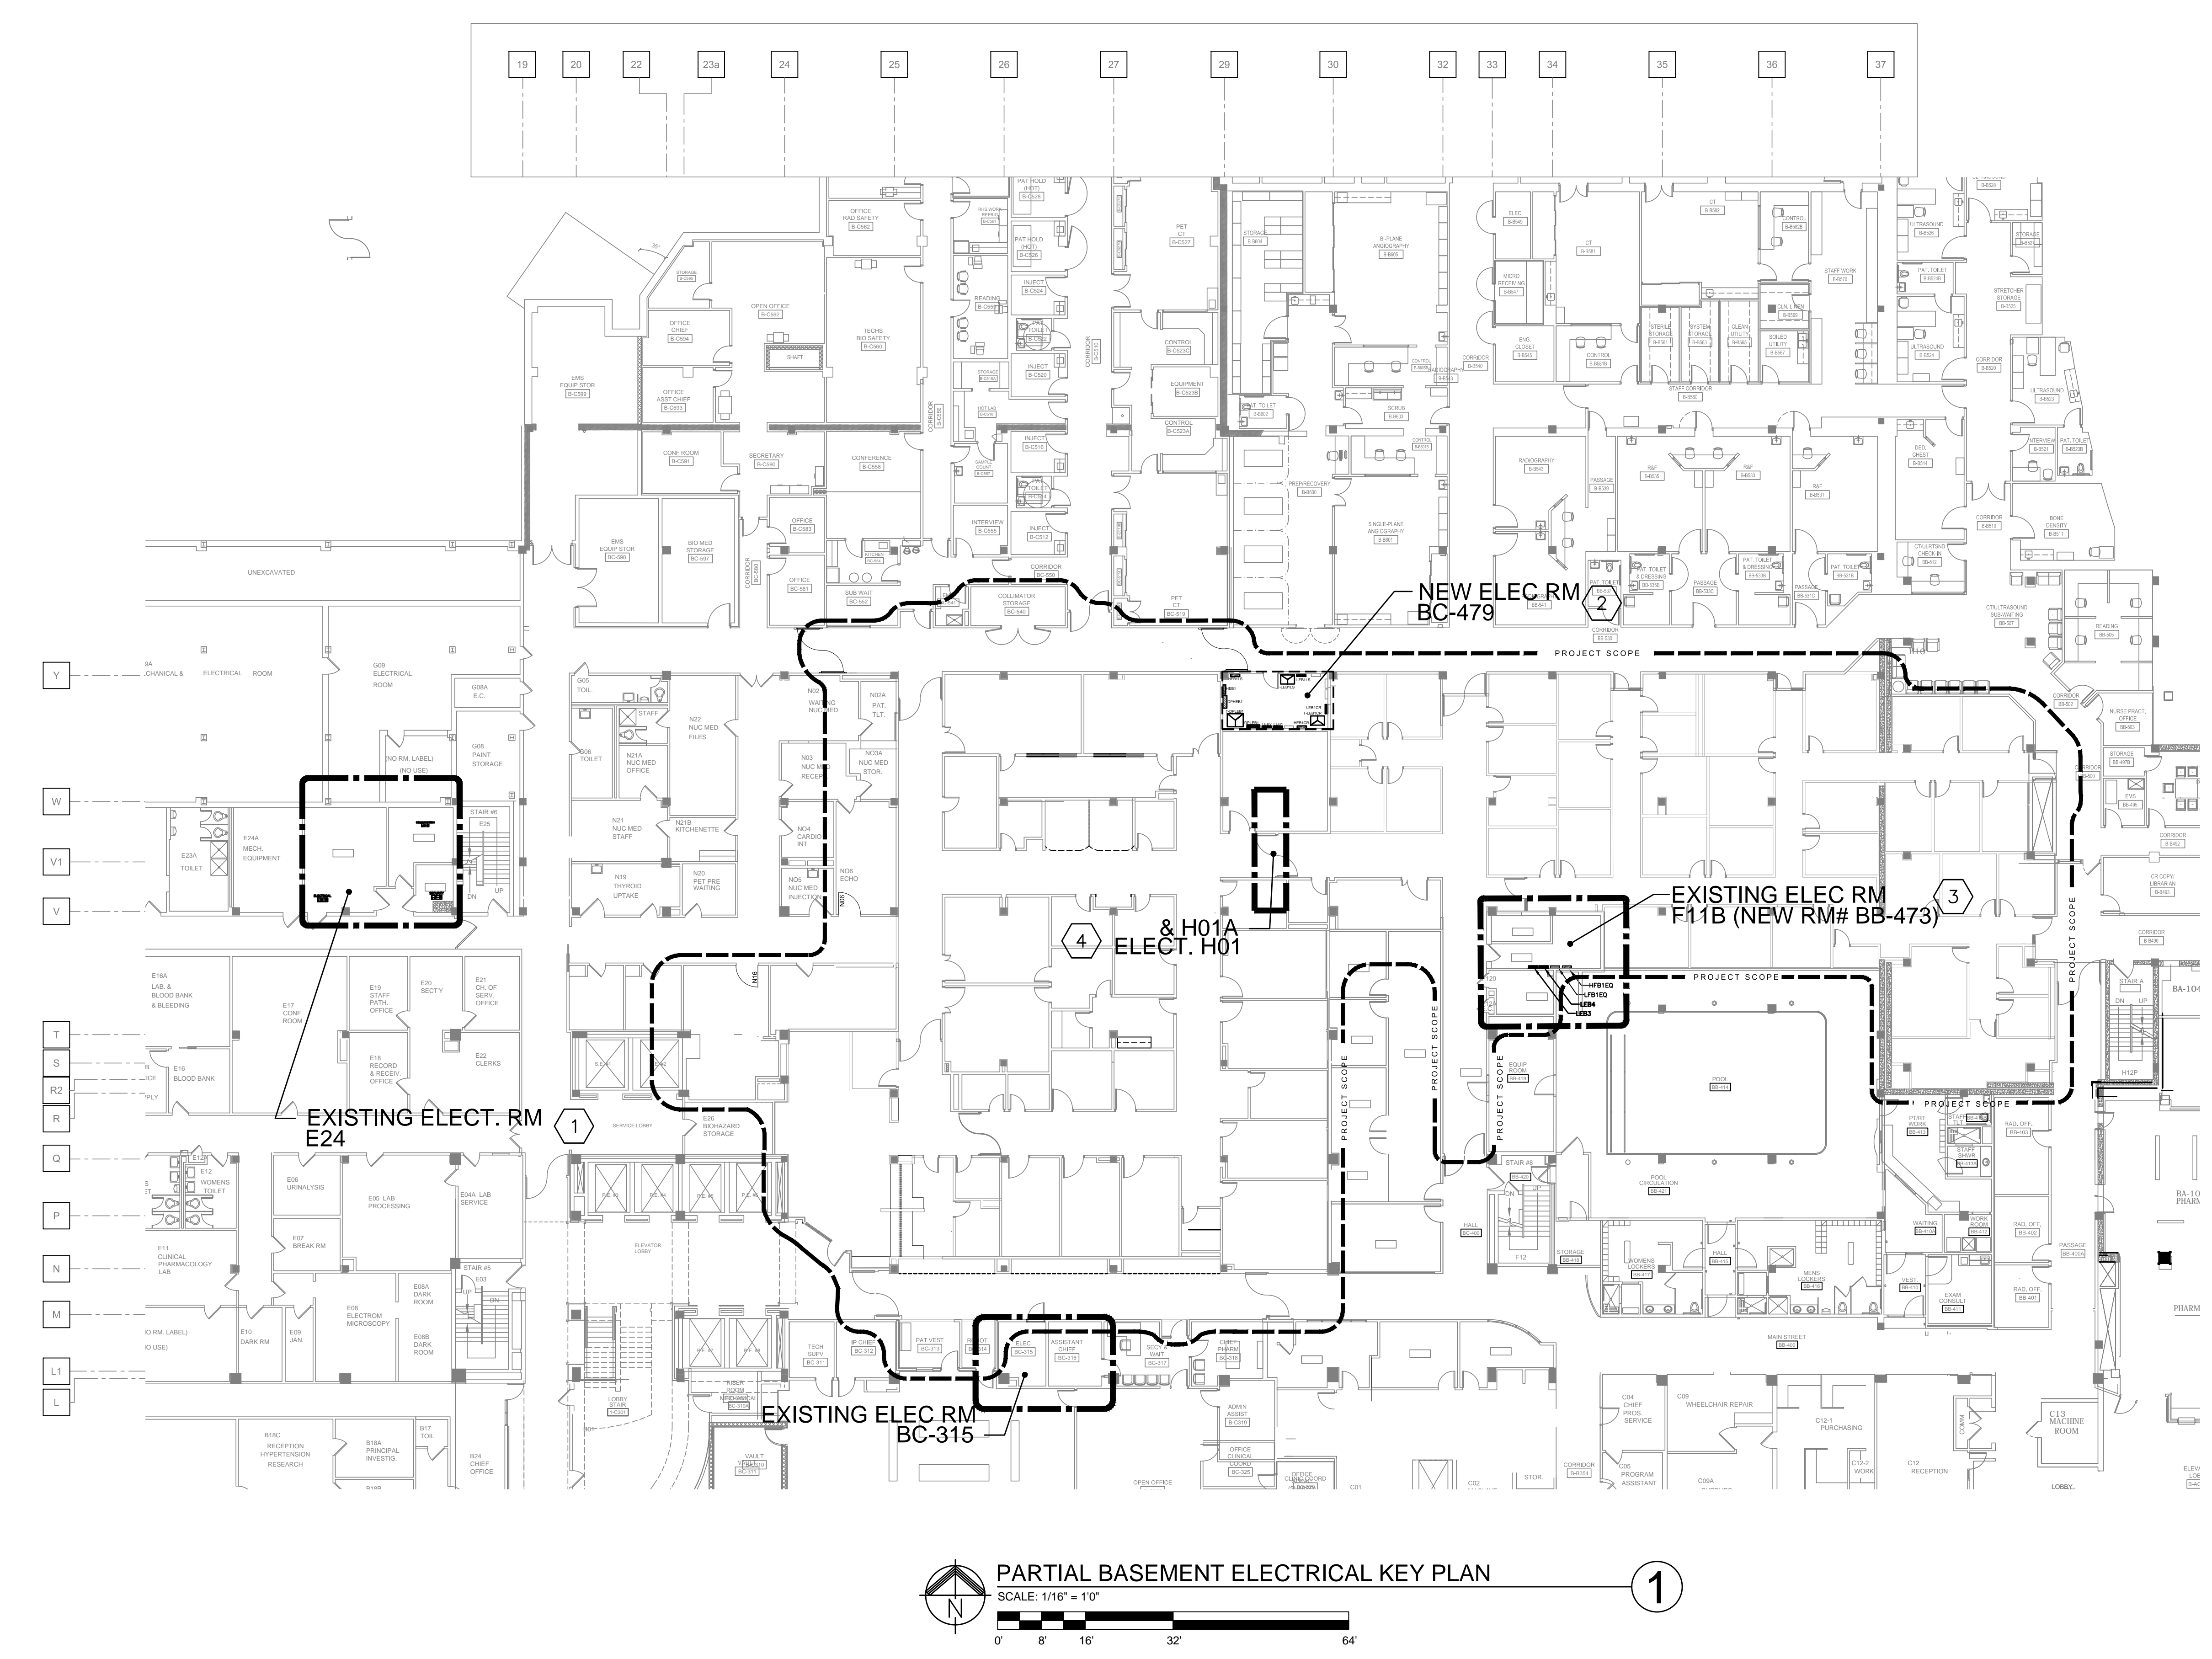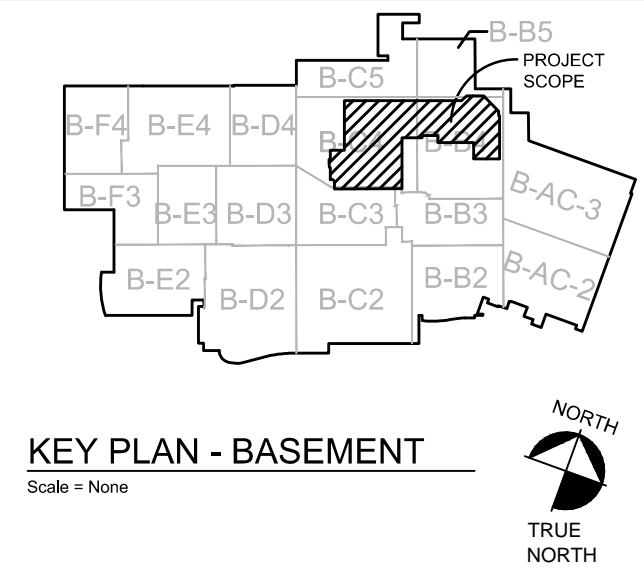

- CODED NOTES:**
- 1 CONNECT NEW LOADS TO EXISTING DISTRIBUTION PANELS. REFER TO POWER DISTRIBUTION ONE LINE DIAGRAM FOR ADDITIONAL INFORMATION.
 - 2 NEW ELECTRICAL ROOM AND DISTRIBUTION TO SUPPLY PROJECT AREA - HALF OF THE ROOM IS CONSTRUCTED UNDER PHASE 1 AND THE REMAINDER IS COMPLETED UNDER PHASE 2.
 - 3 CONNECT NEW LOADS TO EXISTING PANELS. REFER TO FLOOR PLANS FOR ADDITIONAL INFORMATION.
 - 4 EXISTING ELECTRICAL ROOMS H01 AND H01A SHALL BE REMOVED UNDER PHASE 2.
 - 5 PROVIDE DEDICATED 120V-1 ϕ CIRCUIT FOR SECURITY EQUIPMENT. COORDINATE EXACT LOCATION AND MOUNTING HEIGHT WITH COR.
 - 6 PROVIDE DEDICATED 120V-1 ϕ CIRCUIT FOR NURSE CALL EQUIPMENT. COORDINATE EXACT LOCATION AND MOUNTING HEIGHT WITH COR.

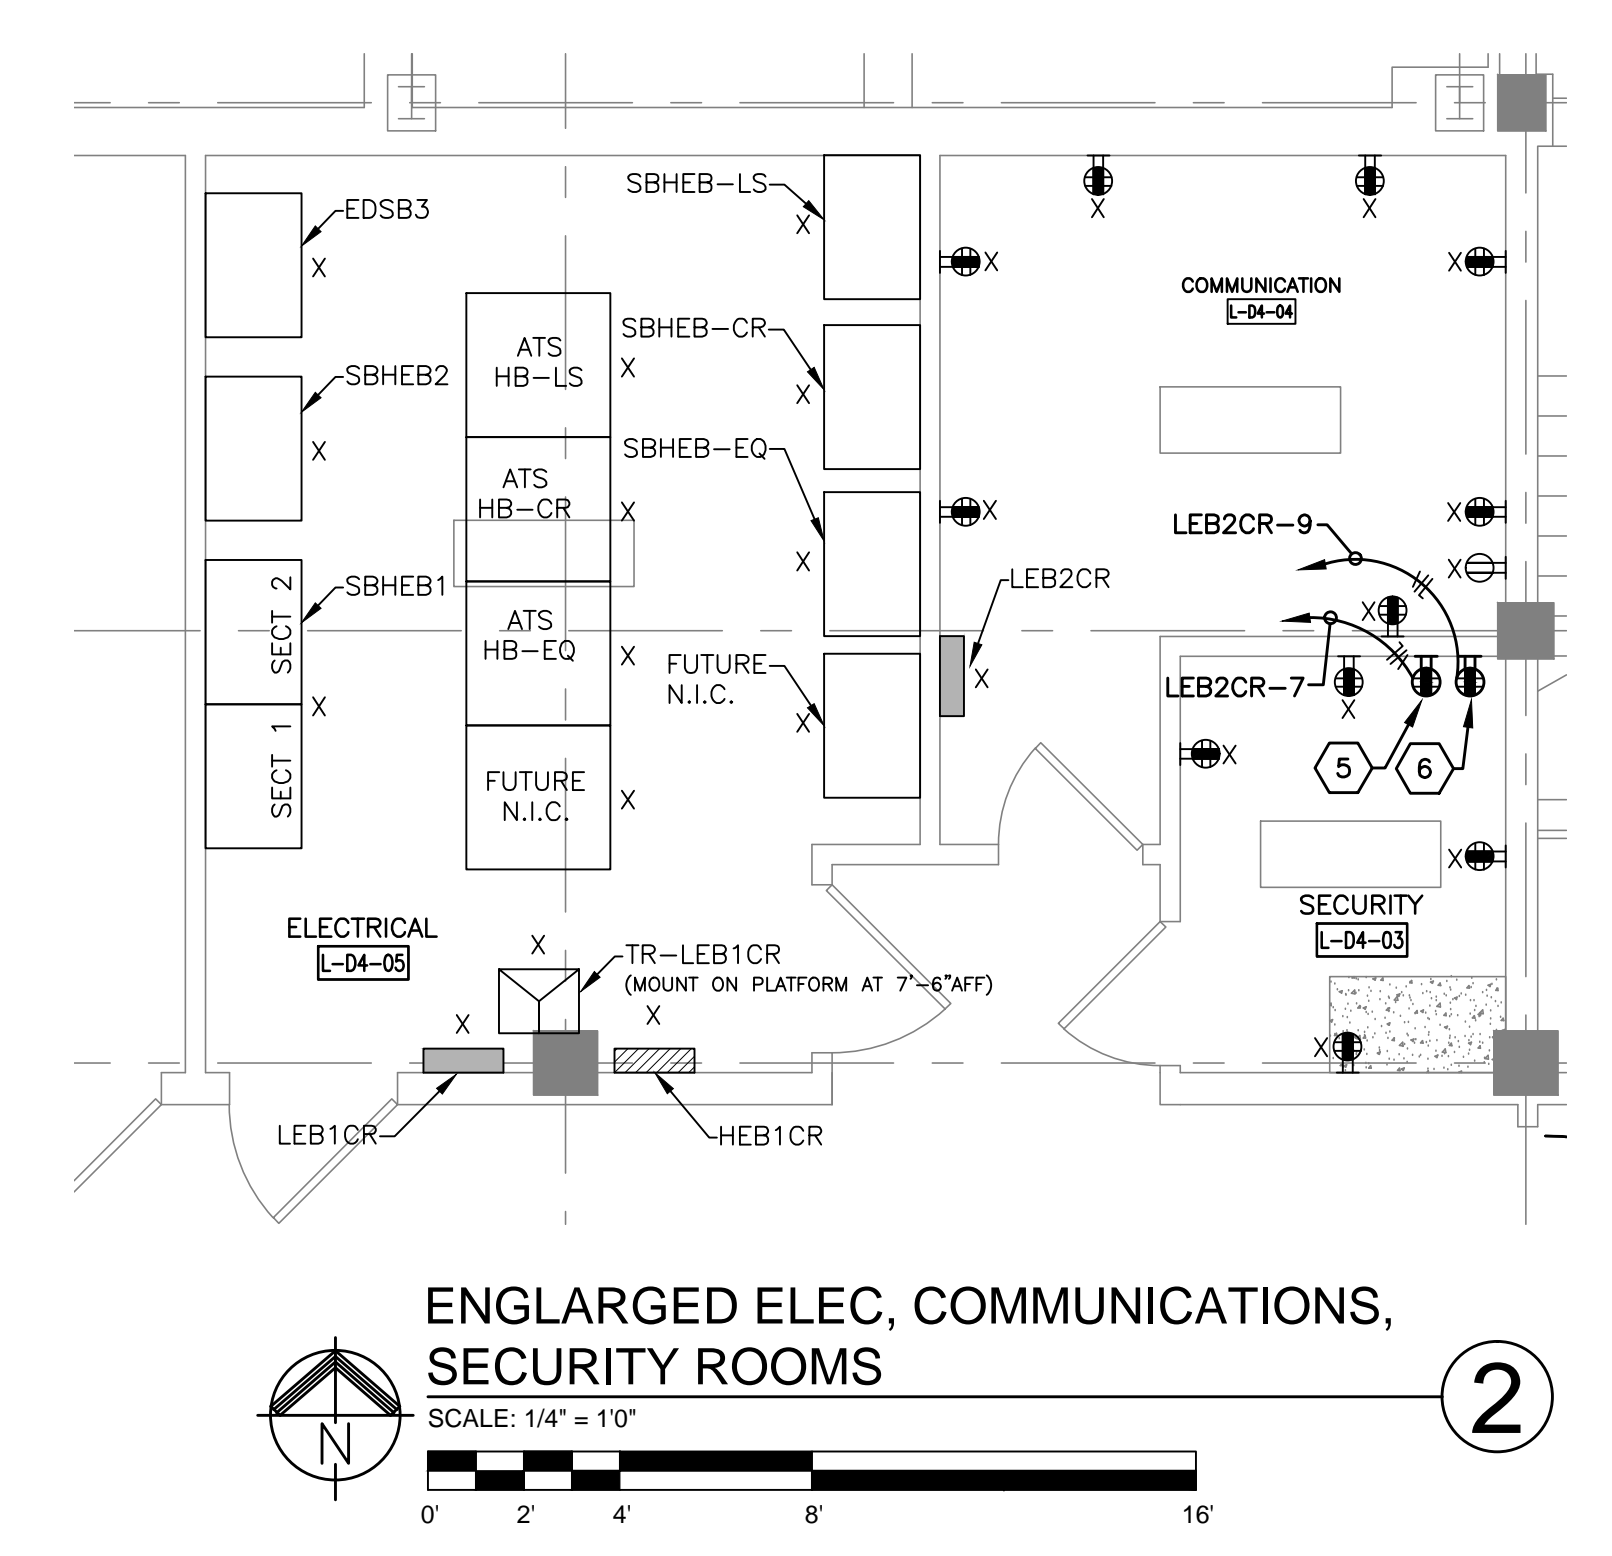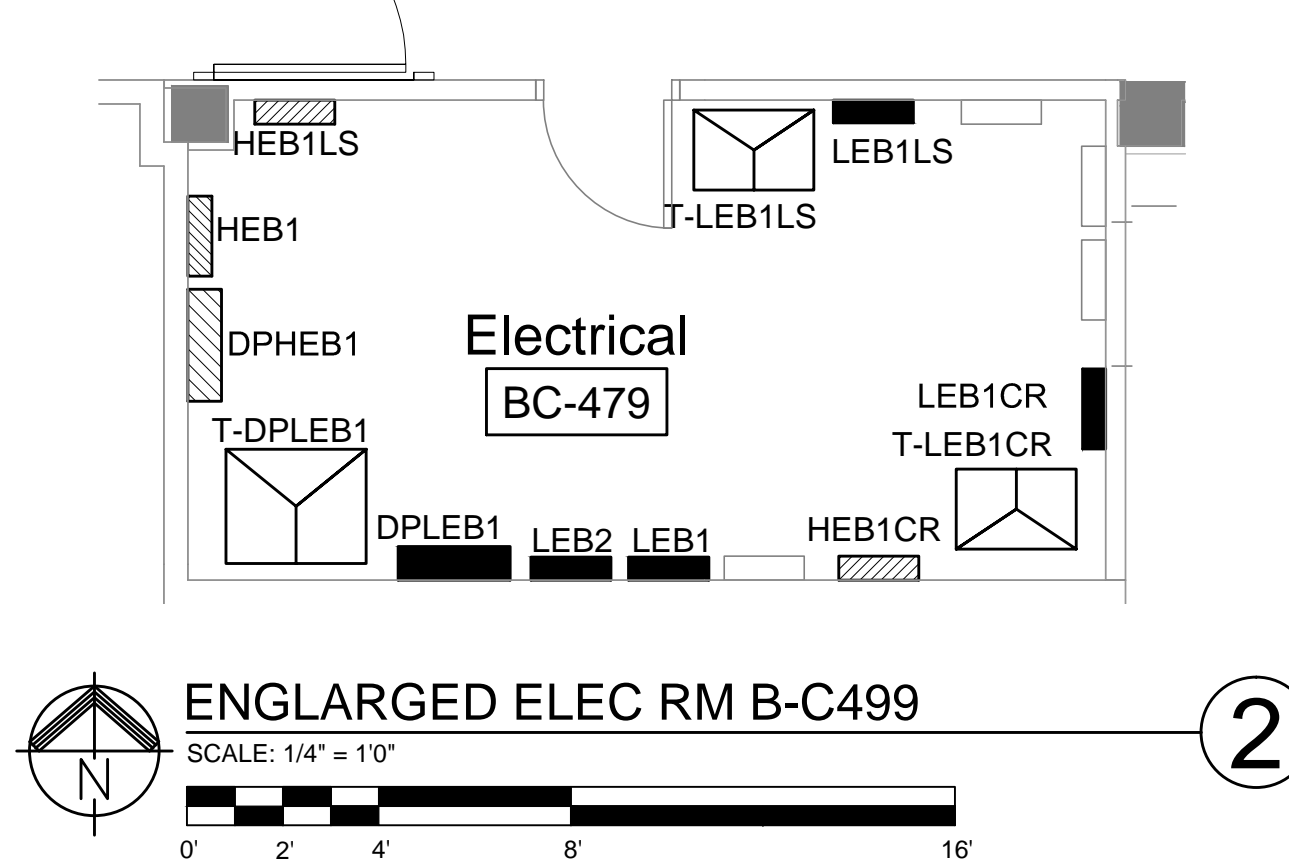


CONSULTANTS:		ARCHITECT:		Drawing Title		Project Title		Project Number		Office of Facilities Management	
FREDRICK, FREDRICK & HELLER ENGINEERS, INC. 672 EAST ROYALTON ROAD BROADVIEW HTS., OHIO 44147 TEL: (440) 546-0606 FAX: (440) 546-0606		Perspectus architecture 13212 Shaker Square Suite 204 Cleveland, Ohio 44120 P. 216.752.1800 F. 216.752.3833		PARTIAL BASEMENT ELECTRICAL KEY PLAN		EXPAND AND RENOVATE NUCLEAR MEDICINE AND RADIOLOGY		541-14-101		Department of Veterans Affairs	
Barber & Hoffman, Inc. Consulting Engineers 2217 East 9th Street, Suite 350 Cleveland OH 44115-1257 216-875-0100 (F) 216-875-0111 barberhoffman.com		Professional Engineer M.P. LONG 504559 FPH #13027		Approved: Project Director		Location VAMC - WADE PARK		Building Number 1			
Bid Issue 01/17/14						Date 1-17-2014		Checked MPL		Drawing Number 1-E1.4	
Revisions:						Drawn TAG		Dwg. of			



Bid Issue	01/17/14
Revisions:	Date

CONSULTANTS:

**FREDRICK, FREDRICK & HELLER
ENGINEERS, INC.**
672 EAST ROYALTON ROAD
BROADVIEW HTS., OHIO 44147
TEL. (440) 546-9696
FAX: (440) 546-9699

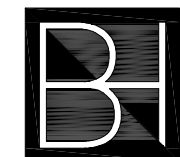

 2217 East 9th Street, Suite 350
Cleveland OH 44115-1257
216-875-0100/ (F) 216-875-0111
barberhoffman.com
BARBER & HOFFMAN, INC.
Consulting Engineers

**ARCHITECT:**

Perspectus
architecture

13212 Shaker Square Suite 204 Cleveland, Ohio 44120
P. 216.752.1800 F.216.752.3833

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Drawing Title

**PARTIAL BASEMENT
LIGHTING DEMOLITION PLAN
PHASE 1**

Approved: Project Director

Project Title

**EXPAND AND RENOVATE
NUCLEAR MEDICINE AND
RADIOLOGY**

Location	VAMC - WADE PARK
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Date	1-17-2014
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Checked MPL	
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Project Number
541-14-101

Building Number	1
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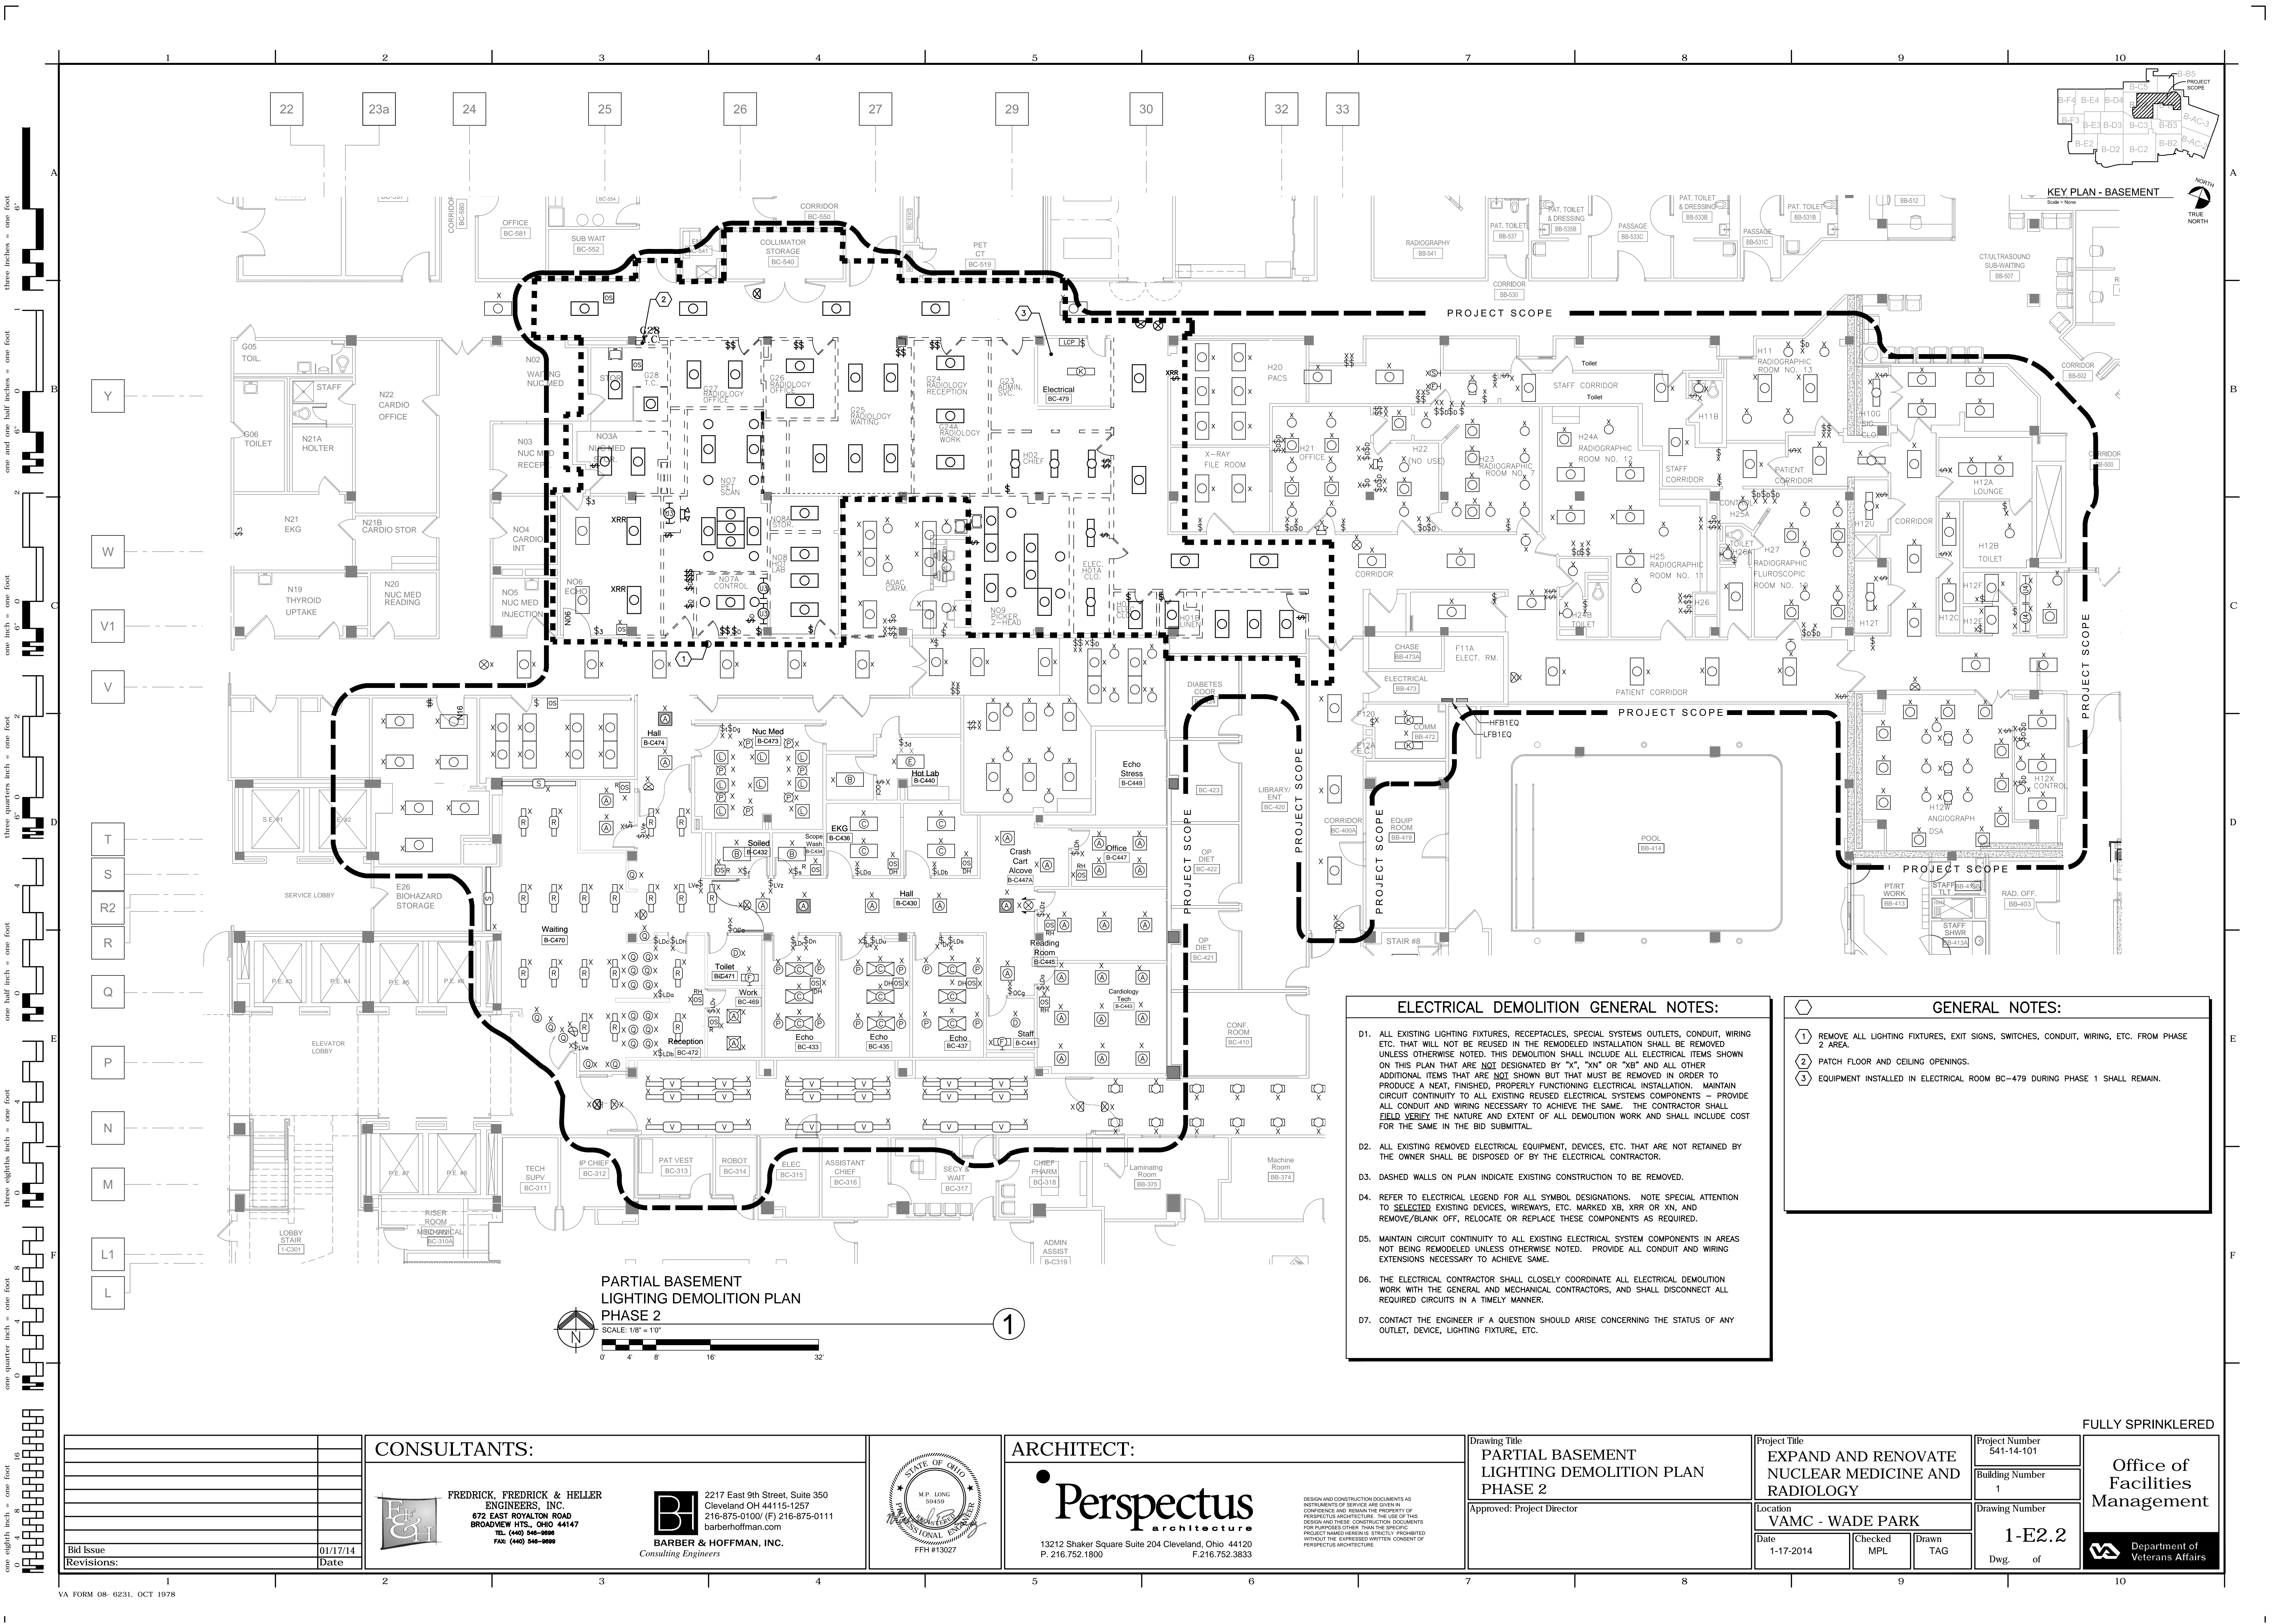
Drawing Number

1-E2

FULLY SPRINKLERED

**Office of
Facilities
Management**





PARTIAL BASEMENT
LIGHTING DEMOLITION PLAN
PHASE 2

SCALE: 1/8" = 1'-0"

1

ELECTRICAL DEMOLITION GENERAL NOTES:

- D1. ALL EXISTING LIGHTING FIXTURES, RECEPTACLES, SPECIAL SYSTEMS OUTLETS, CONDUIT, WIRING ETC. THAT WILL NOT BE REUSED IN THE REMODELED INSTALLATION SHALL BE REMOVED UNLESS OTHERWISE NOTED. THIS DEMOLITION SHALL INCLUDE ALL ELECTRICAL ITEMS SHOWN ON THIS PLAN THAT ARE NOT DESIGNATED BY "X", "XN" OR "XB" AND ALL OTHER ADDITIONAL ITEMS THAT ARE NOT SHOWN BUT THAT MUST BE REMOVED IN ORDER TO PRODUCE A NEAT, FINISHED, PROPERLY FUNCTIONING ELECTRICAL INSTALLATION. MAINTAIN CIRCUIT CONTINUITY TO ALL EXISTING REUSED ELECTRICAL SYSTEM COMPONENTS - PROVIDE ALL CONDUIT AND WIRING NECESSARY TO ACHIEVE THE SAME. THE CONTRACTOR SHALL FIELD VERIFY THE NATURE AND EXTENT OF ALL DEMOLITION WORK AND SHALL INCLUDE COST FOR THE SAME IN THE BID SUBMITTAL.
- D2. ALL EXISTING REMOVED ELECTRICAL EQUIPMENT, DEVICES, ETC. THAT ARE NOT RETAINED BY THE OWNER SHALL BE DISPOSED OF BY THE ELECTRICAL CONTRACTOR.
- D3. DASHED WALLS ON PLAN INDICATE EXISTING CONSTRUCTION TO BE REMOVED.
- D4. REFER TO ELECTRICAL LEGEND FOR ALL SYMBOL DESIGNATIONS. NOTE SPECIAL ATTENTION TO SELECTED EXISTING DEVICES, WIREWAYS, ETC. MARKED XB, XRR OR XN, AND REMOVE/BLANK OFF, RELOCATE OR REPLACE THESE COMPONENTS AS REQUIRED.
- D5. MAINTAIN CIRCUIT CONTINUITY TO ALL EXISTING ELECTRICAL SYSTEM COMPONENTS IN AREAS NOT BEING REMODELED UNLESS OTHERWISE NOTED. PROVIDE ALL CONDUIT AND WIRING EXTENSIONS NECESSARY TO ACHIEVE SAME.
- D6. THE ELECTRICAL CONTRACTOR SHALL CLOSELY COORDINATE ALL ELECTRICAL DEMOLITION WORK WITH THE GENERAL AND MECHANICAL CONTRACTORS, AND SHALL DISCONNECT ALL REQUIRED CIRCUITS IN A TIMELY MANNER.
- D7. CONTACT THE ENGINEER IF A QUESTION SHOULD ARISE CONCERNING THE STATUS OF ANY OUTLET, DEVICE, LIGHTING FIXTURE, ETC.

GENERAL NOTES:

- 1 REMOVE ALL LIGHTING FIXTURES, EXIT SIGNS, SWITCHES, CONDUIT, WIRING, ETC. FROM PHASE 2 AREA.
- 2 PATCH FLOOR AND CEILING OPENINGS.
- 3 EQUIPMENT INSTALLED IN ELECTRICAL ROOM BC-479 DURING PHASE 1 SHALL REMAIN.

CONSULTANTS:

FREDRICK, FREDRICK & HELLER
ENGINEERS, INC.
672 EAST ROYALTON ROAD
BROADVIEW HTS., OHIO 44147
TEL (440) 546-9898
FAX: (440) 546-9899

2217 East 9th Street, Suite 350
Cleveland OH 44115-1257
216-875-0100 (F) 216-875-0111
barberhoffman.com
BARBER & HOFFMAN, INC.
Consulting Engineers



ARCHITECT:

Perspectus
architecture

13212 Shaker Square Suite 204 Cleveland, Ohio 44120
P. 216.752.1800 F. 216.752.3833

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Drawing Title

PARTIAL BASEMENT
LIGHTING DEMOLITION PLAN
PHASE 2

Approved: Project Director

Project Title

EXPAND AND RENOVATE
NUCLEAR MEDICINE AND
RADIOLOGY

Location
VAMC - WADE PARK

Date
1-17-2014

Checked
MPL

Drawn
TAG

Project Number

541-14-101

Building Number

1

Drawing Number


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Office of
Facilities
Management

Department of
Veterans Affairs



PARTIAL BASEMENT
LIGHTING DEMOLITION PLAN
PHASE 4

SCALE: 1/8" = 1'-0"
0' 4' 8' 16' 32'

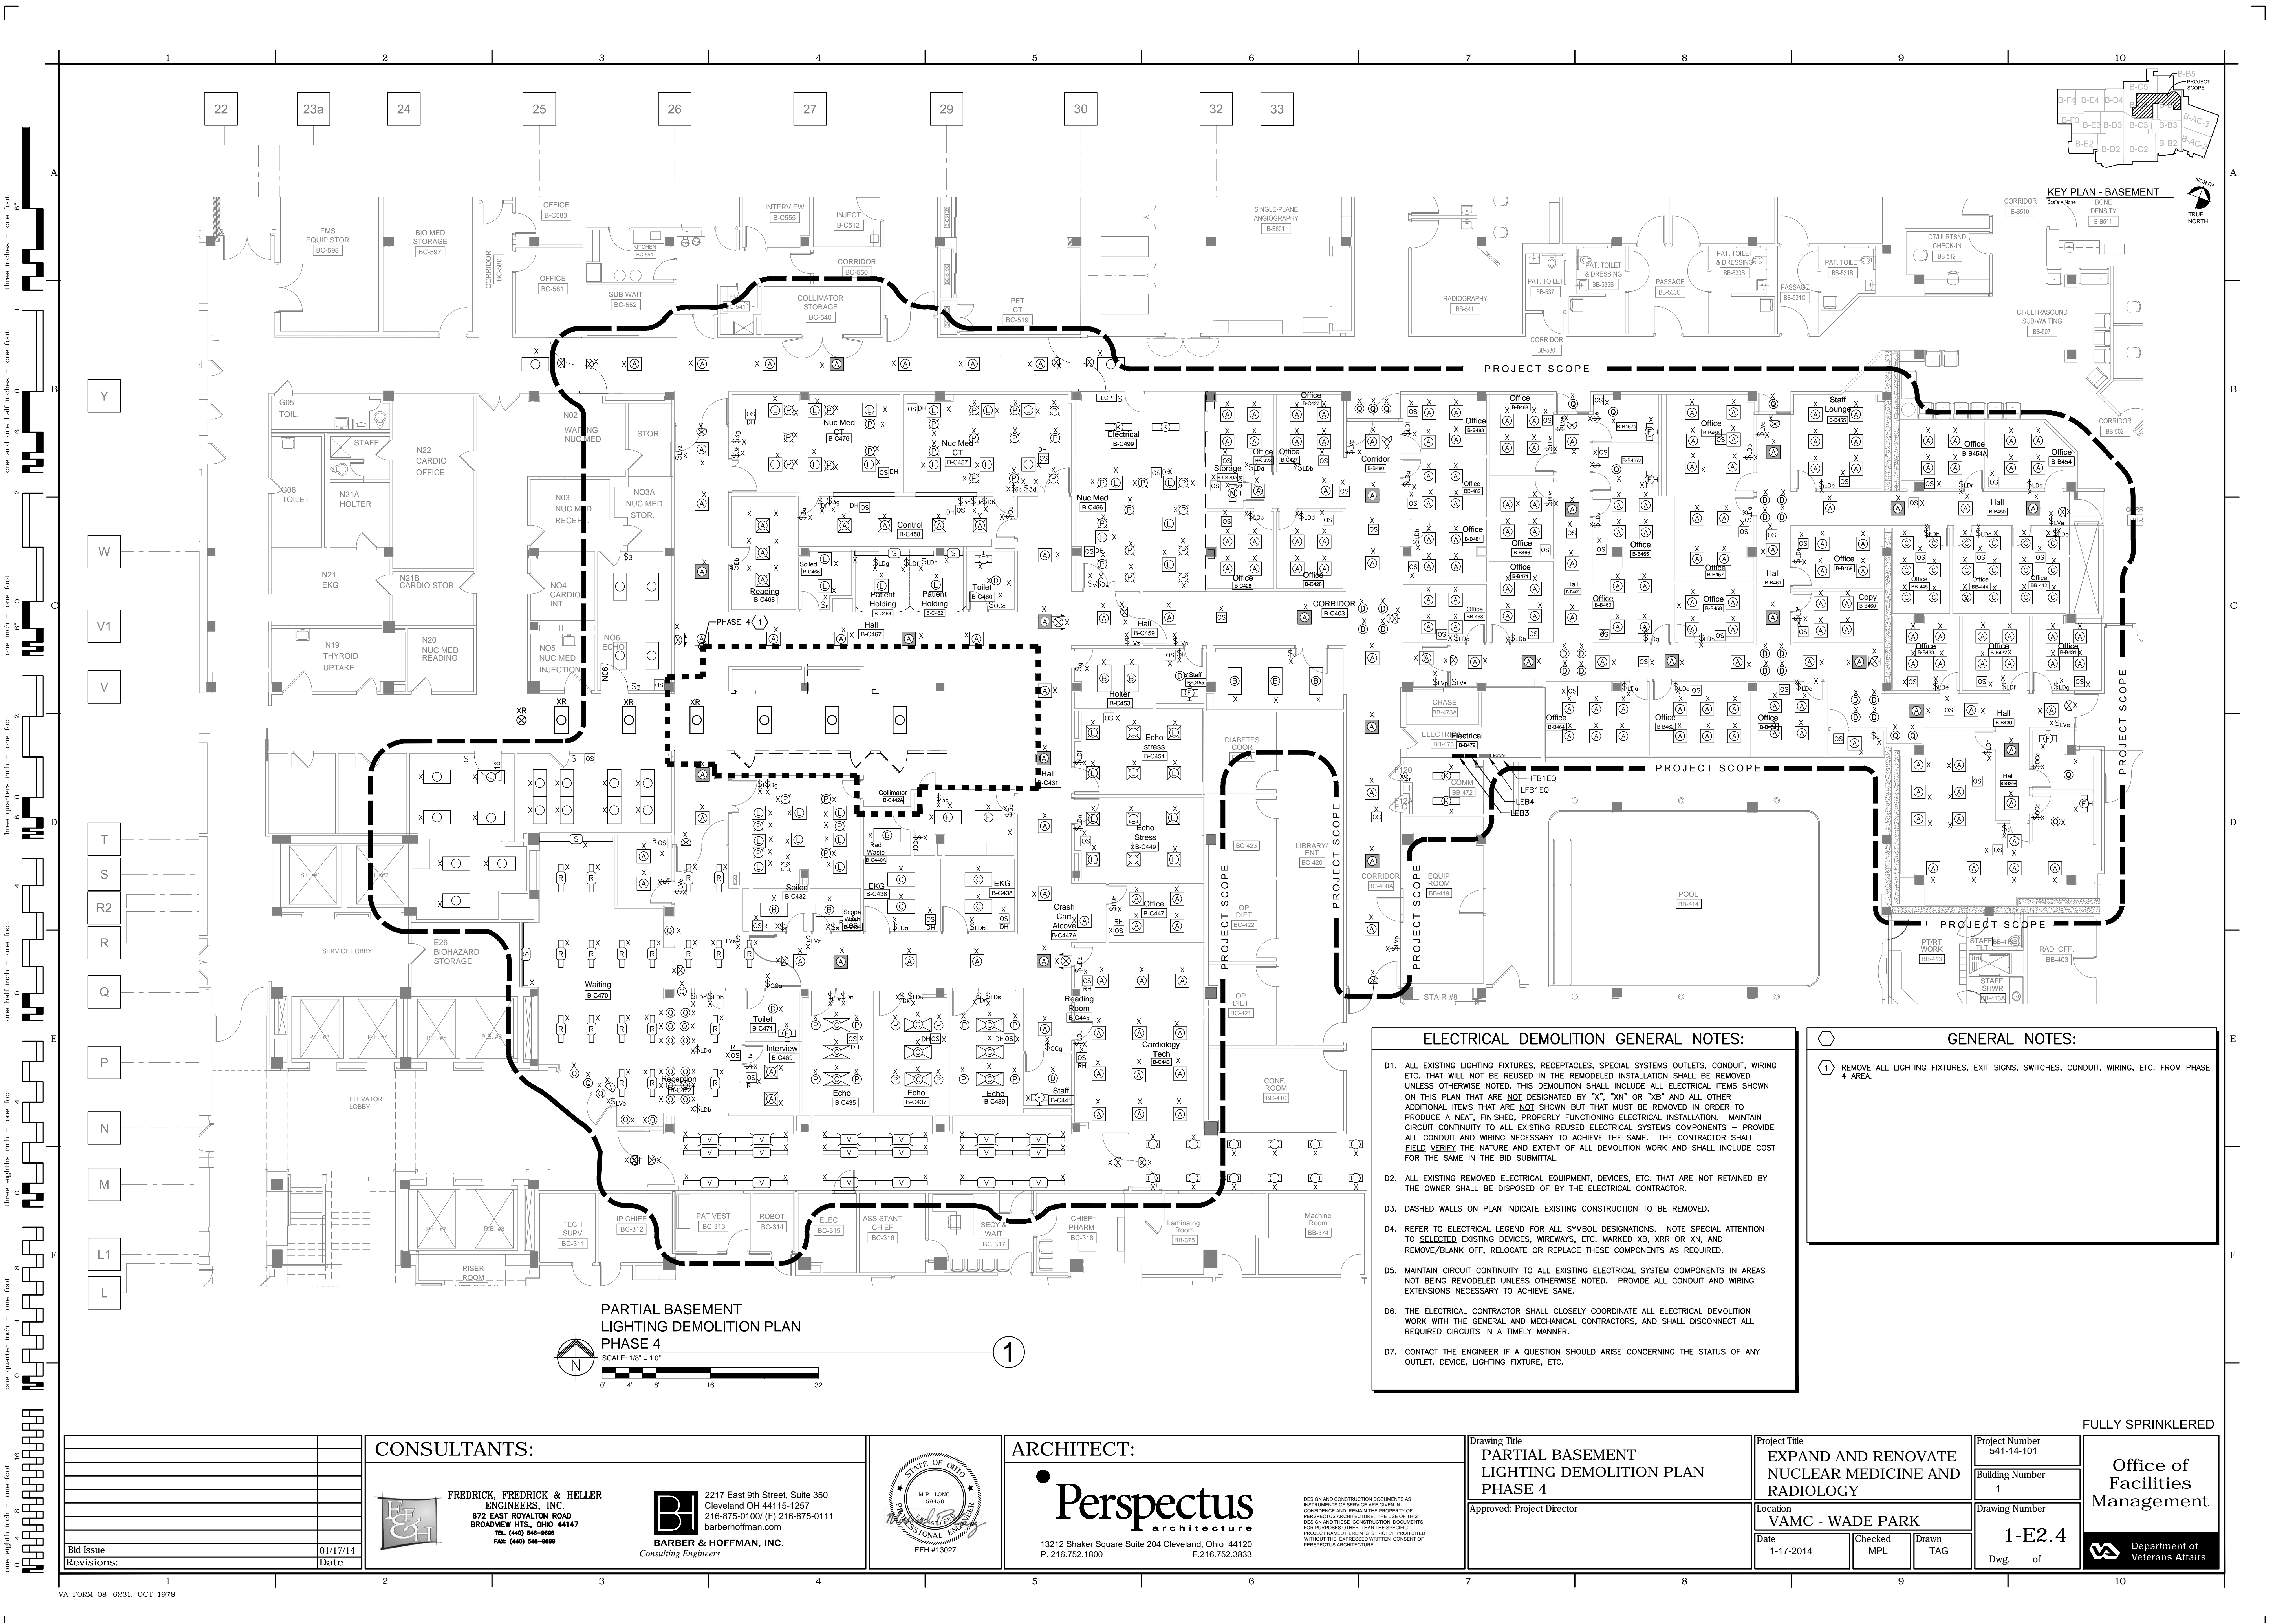ELECTRICAL DEMOLITION GENERAL NOTES:

1. ALL EXISTING LIGHTING FIXTURES, RECEPTACLES, SPECIAL SYSTEMS OUTLETS, CONDUIT, WIRING, ETC. THAT WILL NOT BE REUSED IN THE REMODELED INSTALLATION SHALL BE REMOVED UNLESS OTHERWISE NOTED. THIS DEMOLITION SHALL INCLUDE ALL ELECTRICAL ITEMS SHOWN ON THIS PLAN THAT ARE NOT DESIGNATED BY "X", "XN" OR "XB" AND ALL OTHER ADDITIONAL ITEMS THAT ARE NOT SHOWN BUT THAT MUST BE REMOVED IN ORDER TO PRODUCE A NEAT, FINISHED, PROPERLY FUNCTIONING ELECTRICAL INSTALLATION. MAINTAIN CIRCUIT CONTINUITY TO ALL EXISTING REUSED ELECTRICAL SYSTEMS COMPONENTS - PROVIDE ALL CONDUIT AND WIRING NECESSARY TO ACHIEVE THE SAME. THE CONTRACTOR SHALL FIELD VERIFY THE NATURE AND EXTENT OF ALL DEMOLITION WORK AND SHALL INCLUDE COST FOR THE SAME IN THE BID SUBMITTAL.
2. ALL EXISTING REMOVED ELECTRICAL EQUIPMENT, DEVICES, ETC. THAT ARE NOT RETAINED BY THE OWNER SHALL BE DISPOSED OF BY THE ELECTRICAL CONTRACTOR.
3. DASHED WALLS ON PLAN INDICATE EXISTING CONSTRUCTION TO BE REMOVED.
4. REFER TO ELECTRICAL LEGEND FOR ALL SYMBOL DESIGNATIONS. NOTE SPECIAL ATTENTION TO SELECTED EXISTING DEVICES, WIRWAYS, ETC. MARKED XB, XRR OR XN, AND REMOVE/BLANK OFF, RELOCATE OR REPLACE THESE COMPONENTS AS REQUIRED.
5. MAINTAIN CIRCUIT CONTINUITY TO ALL EXISTING ELECTRICAL SYSTEM COMPONENTS IN AREAS NOT BEING REMODELED UNLESS OTHERWISE NOTED. PROVIDE ALL CONDUIT AND WIRING EXTENSIONS NECESSARY TO ACHIEVE SAME.
6. THE ELECTRICAL CONTRACTOR SHALL CLOSELY COORDINATE ALL ELECTRICAL DEMOLITION WORK WITH THE GENERAL AND MECHANICAL CONTRACTORS, AND SHALL DISCONNECT ALL REQUIRED CIRCUITS IN A TIMELY MANNER.
7. CONTACT THE ENGINEER IF A QUESTION SHOULD ARISE CONCERNING THE STATUS OF ANY OUTLET, DEVICE, LIGHTING FIXTURE, ETC.

GENERAL NOTES:

1. REMOVE ALL LIGHTING FIXTURES, EXIT SIGNS, SWITCHES, CONDUIT, WIRING, ETC. FROM PHASE 4 AREA.

CONSULTANTS:

FREDRICK, FREDRICK & HELLER
ENGINEERS, INC.
672 EAST ROYALTON ROAD
BROADVIEW HTS., OHIO 44147
TEL (440) 546-8888
FAX (440) 546-8888

2217 East 9th Street, Suite 350
Cleveland OH 44115-1257
216-875-0100 (F) 216-875-0111
barberhoffman.com
BARBER & HOFFMAN, INC.
Consulting Engineers



ARCHITECT:

Perspectus
architecture
13212 Shaker Square Suite 204 Cleveland, Ohio 44120
P. 216.752.1800 F. 216.752.3833

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Drawing Title

PARTIAL BASEMENT
LIGHTING DEMOLITION PLAN
PHASE 4

Approved: Project Director

Project Title

EXPAND AND RENOVATE
NUCLEAR MEDICINE AND
RADIOLOGY

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